KELLY KLOSURES

FREMONT, NE 68025

ASSEMBLY DRAWINGS FOR A 21'W X 8' X 45'L KELLY KLOSURE MINI-SPAN FLATROOF ENCLOSURE "SAMPLE ENCLOSURE"

K.K. ORDER #: SAMPLE

P.O. #: SAMPLE

BUILDING NOTES:

BUILDING CODE: N'A (TEMPORARY USE ONLY)
ROOF LOAD: N'A (TEMPORARY USE ONLY)
SNOW DRIFT LOAD: N'A (TEMPORARY USE ONLY)
WIND LOAD: N'A (TEMPORARY USE ONLY)
SEISMIC: N'A (TEMPORARY USE ONLY)

1. THIS BUILDING HAS BEEN DESIGNED IN ACCORDANCE WITH THE BUILDING CODE AND BASIC STRUCTURAL DESIGN DATA LISTED ABOVE. THE BUILDING HAS BEEN DESIGNED AND ENGINEERED FROM A STRUCTURAL ASPECT ONLY. OTHER CODE COMPLIANCE ISSUES SUCH AS OCCUPANCY, EGRESS, HVAC, ELECTRICAL, MECHANICAL, FIRE SAFETY ETC. IS THE RESPONSIBILITY OF THE END USER OR ITS REPRESENTATIVES.

IMPORTANT NOTE:

DUE TO VIBRATION DURING THE SHIPPING PROCESS SOME TEK SCREWS THAT HOLD THE FACTORY INSTALLED EXTERIOR SHEETING, INSULATION AND INTERIOR LINER TO THE PANEL STRUCTURAL FRAME MAY HAVE BEEN LOOSENED. THE BUILDING ERECTOR IS TO CHECK AND TIGHTEN ALL OF THE SCREWS PRIOR TO BUILDING ASSEMBLY.

MANUFACTURERS DISCLAIMER


THE MANUFACTURER HAS DESIGNED AND ENGINEERED THIS SYSTEM. VARIATIONS AND/OR MODIFICATIONS TO THE SYSTEM OR COMPONENTS WILL VOID AND NULLIFY ANY AND ALL WARRANTIES, BOTH WRITTEN AND/OR IMPLIED, AND LIABILITY FOR DEFECTS IN THIS SYSTEM AND IT'S COMPONENTS. MANUFACTURER FURTHER ACCEPTS NO RESPONSIBILITY AND/OR LIABILITY FOR OBTAINING OR MAINTAINING ANY LOCAL, REGIONAL OR NATIONAL BUILDING PERMITS, INSPECTIONS OR DOCUMENTS THAT MAY BE REQUIRED.


BOLTING NOTE:

ALL BOLTS W/ NUTS SHALL BE "SNUG-TIGHT" (SNUG-TIGHTENED CONDITION IS THE TIGHTNESS THAT IS ATTAINED WITH A FEW IMPACTS OF AN IMPACT WRENCH OR THE FULL EFFORT OF AN CREW MEMBER USING AN ORDINARY SPUD WRENCH TO BRING THE CONNECTED PLIES INTO FIRM CONTACT)


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PANEL & PANEL RACK HANDLING TIPS

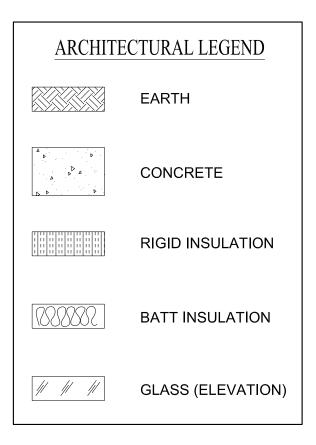


UNLOADING AND LIFTING PANEL RACKS VITH A FORKLIFT

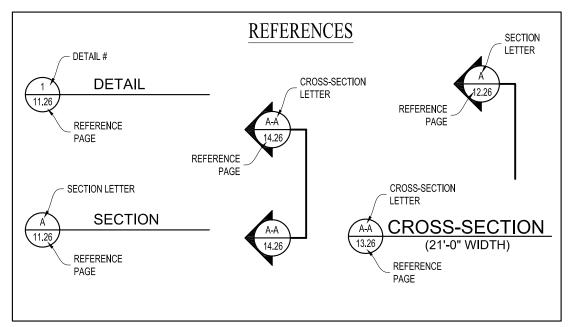UPPER RACKS SHOULD BE REMOVED FROM THE TRUCK FIRST AND PLACED AROUND THE WORKING AREA

PROTECTED ZONE

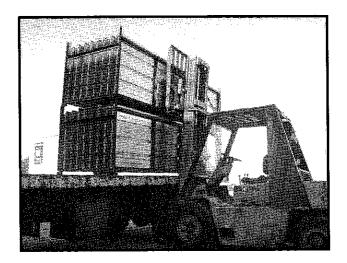SHEETING OVERLAPS

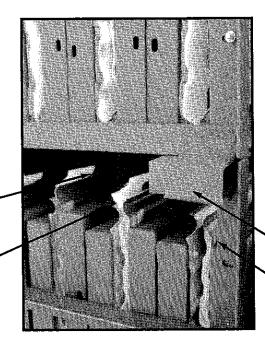


STORING PANEL RACKS IN STACKED POSITIONS

WHEN PANEL RACKS ARE STORED IN A STACKED (ONE ON TOP OF THE OTHER) POSITION ON SITE, THE FEET OF THE UPPER RACK MUST NEST INTO THE UPPER END OF THE BOTTOM RACK FRAMING (AS SHOWN) THIS KEEPS RACKS SPACED, MAINTAINING A PROTECTION ZONE FOR THE SHEETING OVERLAPS.


UPPER RACK FOOT

BOTTOM RACK FRAME

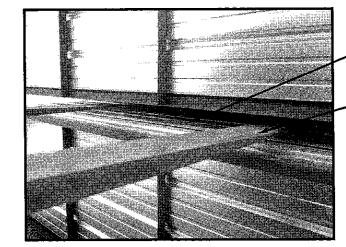


SHEETING OVERLAPS

FORKLIFT FORKS

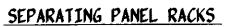

WHEN LIFTING RACKS ONE OFF THE OTHER WITH A FORKLIFT. SPECIAL CARE MUST BE TAKEN TO PREVENT THE FORKS OF THE FORKLIFT FROM DAMAGING THE SHEETING OVERLAPS THAT PROTRUDE ABOVE THE BOTTOM PANEL RACKS THIS MATERIAL IS MORE SUSCEPTIBLE TO DAMAGE THAN THE PANEL FRAMES.


FORKLIFT FORKS

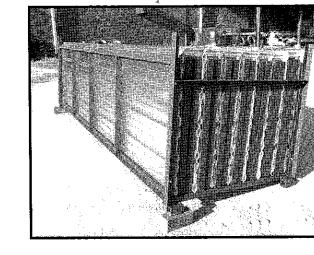



SHEETING OVERLAPS (CAUTION !)

BOTTOM RACK

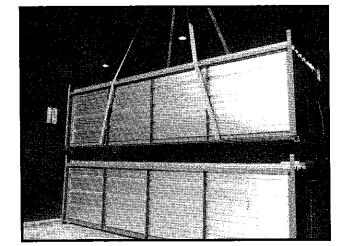

LIFTING PANEL RACKS VITH SLINGS

AN OPTIONAL METHOD OF UNLOADING PANELS IS SHOWN IN THIS ILLUSTRATION, USING SLINGS HUNG FROM A CRANE OR CHERRY PICKER INSTEAD OF A FORKLIFT TO UNLOAD PANEL RACKS FROM THE TRUCK

REMOVING PANELS FROM RACKS

WHEN PANEL RACKS ARE REMOVED FROM THE TRUCK AND PLACED AROUND THE STAGING AREA. THE FRONT TWO CORNERS OF EACH RACK SHOULD BE BLOCKED UP. THIS PREVENTS PANELS FROM TIPPING OUT AS PANELS ARE REMOVED. IF THIS IS NOT DONE THEN THERE IS THE POTENTIAL FOR PANEL DAMAGE.



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PANEL & PANEL RACK HANDLING TIPS

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PAGE #1

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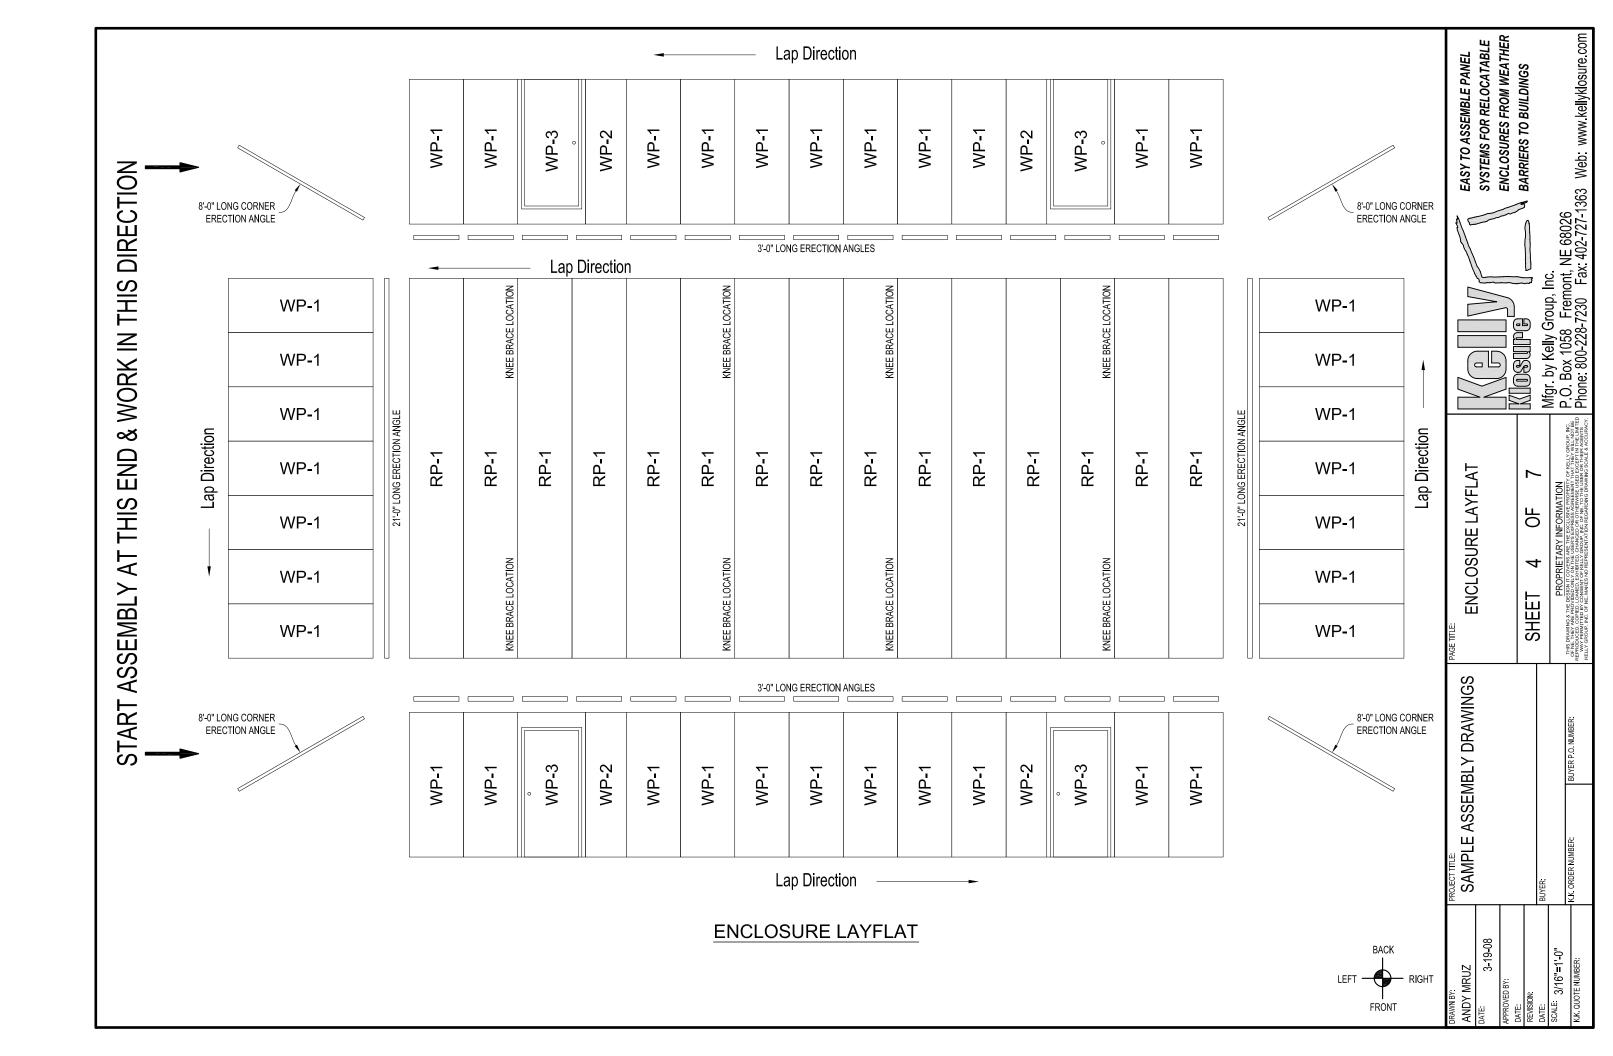
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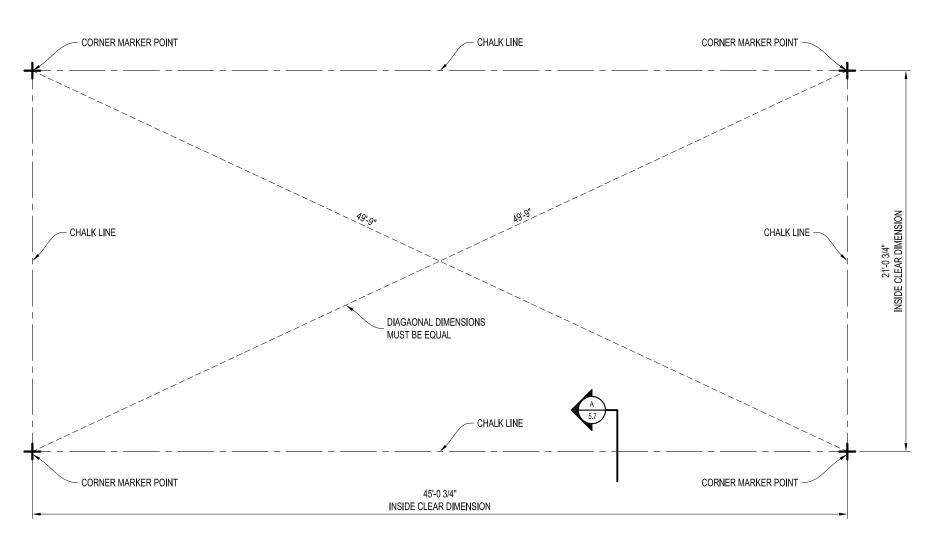


Qty Description									
36	3082			Wall Panel 3'x8'x2"					
WP-1	29GV	I15	LG	29Ga Galvalume Sht	1.1/2" Insul.	28Ga Galv. Liner			
4	2308			Wall Panel 2'-3"x8'x2"					
WP-2	29GV	I15	LG	29Ga Galvalume Sht	1.1/2" Insul.	28Ga Galv. Liner			
4	3908	RSO		Door Panel 3'-9"x8'x2"		3'x7' P. Door (HRSO)			
WP-3	29GV	I15	LG	29Ga Galvalume Sht	1.1/2" Insul.	28Ga Galv. Liner			
15	FR3214			Flat Roof Panel 3'x21'x4"					
RP-1	29GV	I15	LG	29Ga Galvalume Sht	1.1/2" Insul.	28Ga Galv. Liner			
2	2219	A3		21' Flat Roof Erection Ang	Angle L3x2x3/16				
4	2089	A15		8' Erection Angle					
30	2039H	A3		<u>U</u>	3' Flat Roof Erection Angle - Heavy L3x2x3/16				
8		A3		Knee Brace - 3'-6.3/4" L3x2x3/16					
Qty				Description					
1			-	rings (w/MSDS Sheets)					
1	Pint			anel Frames Red Primer					
1	Pint		p Paint - D						
4			Door Kno						
4			Door Clo						
32			osure Strip			Imperial Rib			
77	Ft.		Insulation						
6	Rolls		Base Seal						
2	Tubes		ulking - Cl	ear					
	<u>Buildin</u>								
300			Bolt, Zinc						
300			Zinc Plate						
300			Bolt, Zinc						
300			Zinc Plate	ed					
	Building								
4		8' Corner				Galvalume			
15		10' Eave Flashing			Galvalume				
250		#8-18 x 1	1/2 T-2 Sc	rew		Galvanized			


EASY TO ASSEMBLE PANEL
SYSTEMS FOR RELOCATABLE
ENCLOSURES FROM WEATHER

A BARRIERS TO BUILDINGS Mfgr. by Kelly Group, Inc. P.O. Box 1058 Fremont, NE 68026 Phone: 800-228-7230 Fax: 402-727-1363 Web: www.kellyklosure.com DPRIETARY INFORMATION MATERIAL LIST ᆼ $^{\circ}$ SHEET THIS DRAWING & THE D OF NE. THEY ARE PROVI REPRODUCED, COPIED, LI WAY PERMITTED BY C KELLY GROUP, INC. OF NE SAMPLE ASSEMBLY DRAWINGS 3-19-08 SCALE: 3/16"=1'-0" K.K. QUOTE NUMBER: DRAWN BY: ANDY MRUZ





FOUNDATION PREPARATION PLAN VIEW

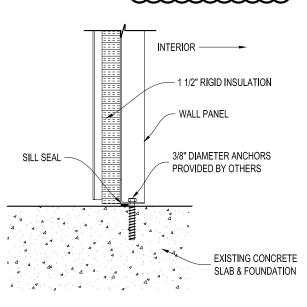

ANCHORS REQUIRED: (88) 3/8" DIAMETER ANCHORS

PROVIDED BY OTHERS

A PANEL BASE SECTION
5.7 SCALE: 1 1/2" = 1'-0"

A - STEP #1 - MARKER POINTS

USING THE DIMENSIONS AS SHOWN, MARK THE FOUR INSIDE BUILDING CORNER DIMENSIONS.


B - STEP #2 - DIAGONAL MEASUREMENT


MEASURE THE DIAGONALS (DIAGONAL MEASUREMENTS MUST BE EQUAL), CORRECT IF NECESSARY BY SHIFTING THE CORNERS WITHOUT CHANGING THE LENGTH OR WIDTH DIMENSIONS.


C - STEP #3 - CHALK LINE

USING THE SQUARED MARKER POINTS, SNAP A CHALK LINE AS SHOWN. (THE CHALK LINE SIGNIFIES THE INSIDE BUILDING DIMENSIONS)

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HALK	DRAWN BY: ANDY MRUZ DATE: 3-19-08	APPROVED BY: DATE:	REVISION:	DATE:	SCALE: 3/16"=1'-0"	K.K. QUOTE NUMBER:	

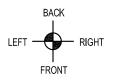

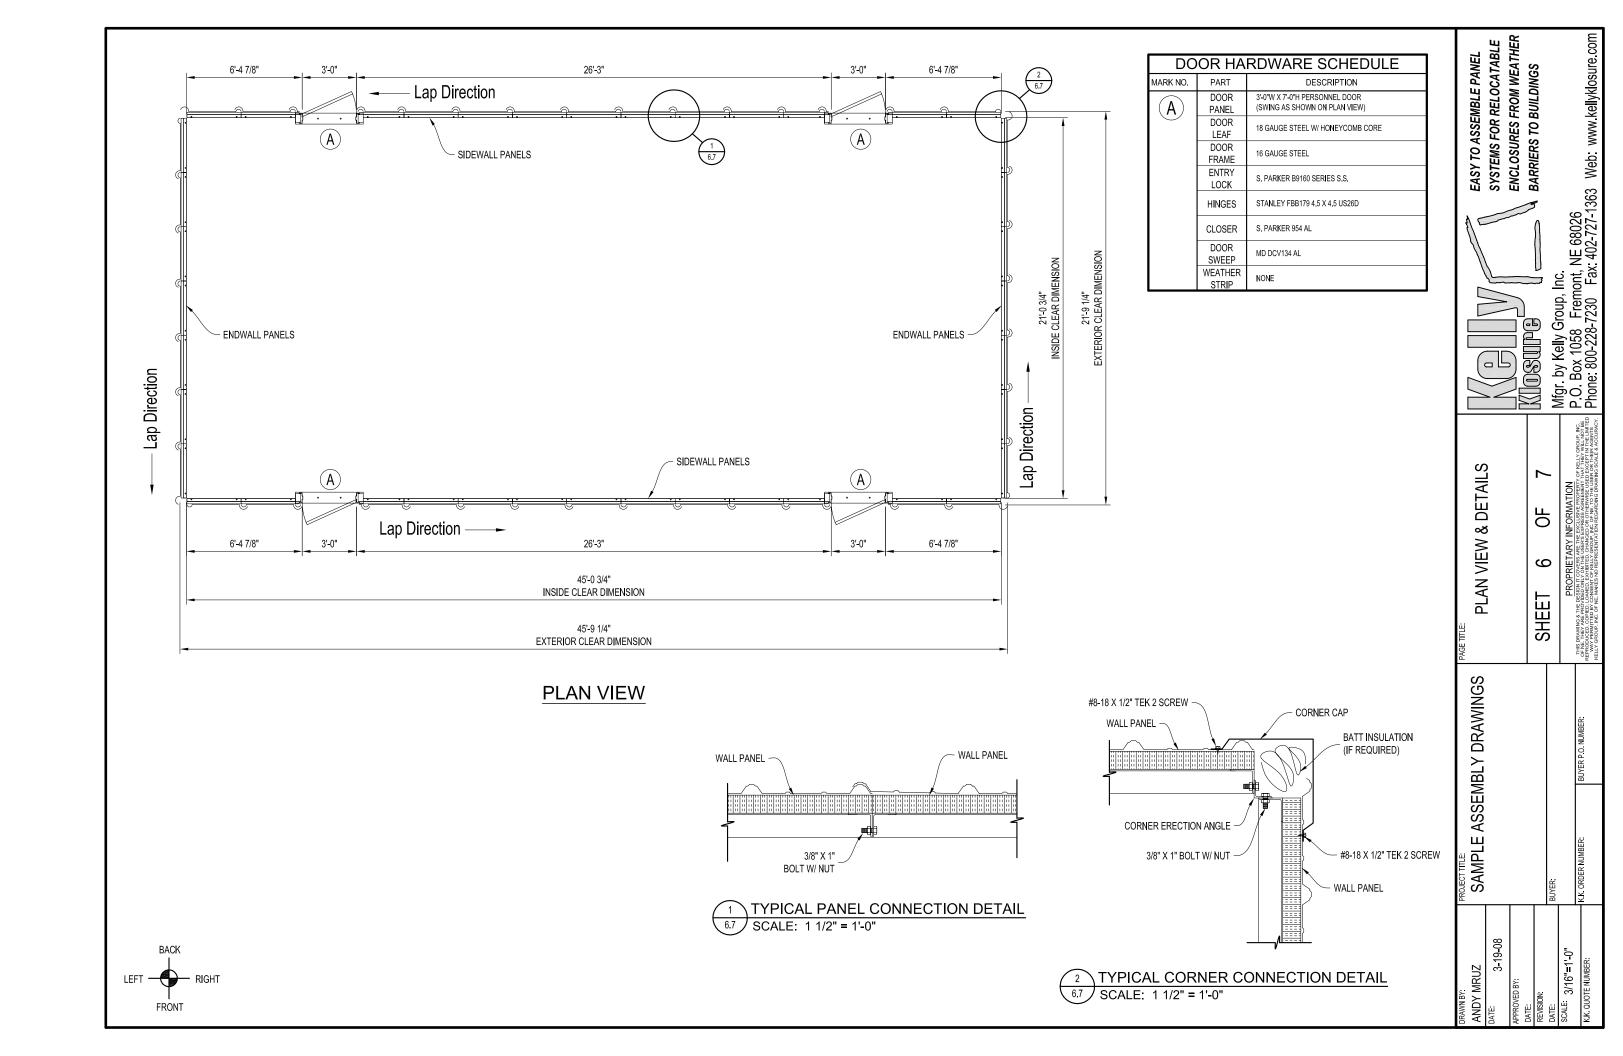

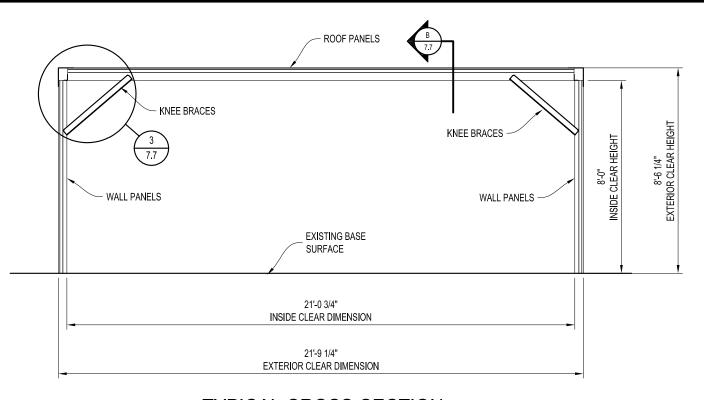

TYPICAL CROSS-SECTION THROUGH THE WIDTH



- ROOF PANEL

2'-6" ROOF PANEL EAVE FLASHING ERECTION ANGLE -#8-18 X 1/2" TEK 2 SCREW \bigcirc 1/2" X 1" BOLT W/ NUT 1/2" X 1" _ 3/8" X 1" BOLT W/ NUT BOLT W/ NUT **©** - WALL PANEL KNEE BRACE 3/8" X 1" BOLT W/ NUT

> KNEE BRACE ATTACHMENT SCALE: 1 1/2" = 1'-0"


$\left(B\right)$	ROOF PANEL CONNECTION DETAIL
7.7	SCALE: 1 1/2" = 1'-0"


1/2" X 1"


BOLT W/ NUT

ROOF PANEL -

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g 2	SAMPLE ASSEMBLY DRAWINGS			BUYER:		

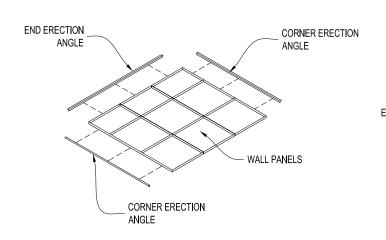

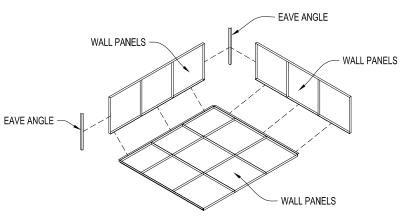

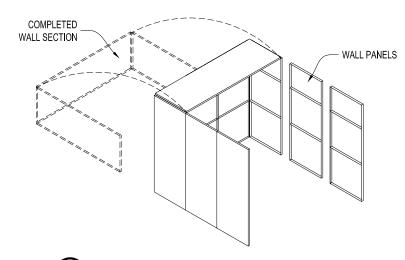

RAISE THE COMPLETED WALL SECTION INTO POSITION AND ANCHOR THE PANELS AT THE BASE AS REQUIRED.

ADD TWO (2) MORE WALL PANELS TO EACH SIDE.

(AS SHOWN ABOVE)

LAYOUT AND KEY TOGETHER THE WALL PANELS THAT MAKE UP THE ONE ENDWALL. BOLT THE END ERECTION ANGLE, AND THE CORNER ERECTION ANGLES TO THE WALL PANELS AS SHOWN ABOVE.

BOLT ONE ROOF PANEL AND TWO WALL PANELS (ONE EACH SIDE) TO THE ENDWALL SECTION. ALSO BOLT TWO (2) EAVE ANGLES TO THE WALL & ROOF PANELS AS SHOWN ABOVE.

ROOF PANELS W/ EAVE ANGLES

BOLT TWO (2) EAVE ANGLES TO A ROOF PANEL AND LIFT IT INTO PLACE. BOLT THE EAVE ANGLES TO THE WALL PANELS AND KEY THE ROOF PANELS TOGETHER WITH LOCKING KEYS. ADD MORE WALL & ROOF PANELS AS REQUIRED UNTIL SIDEWALLS & ROOF IS COMPLETED. (SEE STEP #3 FOR WALL PANEL INSTALLATION)

REPEAT STEP #1 FOR THE OTHER ENDWALL. RAISE THE WALL INTO POSITION AND BOLT IT TO THE PREVIOUS WALL AND ROOF PANELS.

INSTALL ALL CORNER CAPS & FLASHING.

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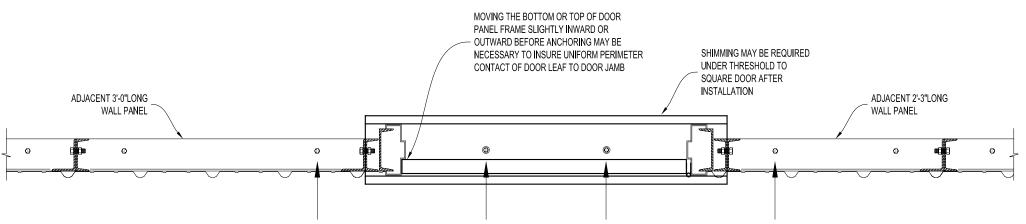
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MINI-SPAN FLAT ROOF ASSEMBLY SEQUENCE

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ATTENTION INSTALLER:

DOOR PANEL MUST BE POSITIONED AND ADJUSTED IN THE FIELD. DUE TO CONDITIONS OF THE FOUNDATION / FLOOR, WE HAVE NO CONTROL OVER PROPER ALIGNMENT OF DOOR PANEL.



DURING BUILDING ASSEMBLY DO NOT INSTALL ANCHOR BOLTS AT THESE LOCATIONS UNTIL DOOR HAS BEEN PROPERLY ALIGNED.

BEFORE DOOR PANEL IS TO BE ANCHORED, ASSEMBLE AND ERECT THE CORRESPONDING ROOF PANELS AND ACCESSORIES WITHIN THIS AREA.

ANY INFIELD REPAIRS OR MODIFICATIONS DONE BY THE INSTALLER ARE THE SOLE RESPONSIBILITY OF THE INSTALLER.

FACTORY QUALITY CONTROL

DOORS ARE INSPECTED AT THE MANUFACTURING FACILITY FOR SQUARENESS AND PROPER DIMENSIONS BEFORE SHIPMENT. IF PRODUCT DAMAGE IS INCURRED DURING SHIPMENT, THIS DAMAGE MUST BE NOTED ON THE RECEIVING NOTICE AT THE TIME OF OFF LOADING AT THE BUILDING SITE. THE MANUFACTURER MUST BE NOTIFIED OF SUCH DAMAGE IMMEDIATELY.

IMPORTANT NOTE:

OVERHEAD DOORS ARE SUPPLIED ONLY!

INSTALLATION & SERVICE BY OTHERS!

(INSTRUCTIONS FOR OVERHEAD DOOR ARE INCLUDED WITH THE DOOR)

FOR FACTORY ASSISTANCE IN DOOR ALIGNMENT CALL 800-228-7230

DOOR INSTALLATION

EASY TO ASSEMBLE PANEL SYSTEMS FOR RELOCATABLE ENCLOSURES FROM WEATHER BARRIERS TO BUILDINGS Mfgr. by Kelly Group, Inc. P.O. Box 1058 Fremont, NE 68026 Phone: 800-228-7230 Fax: 402-727-1363 Web: www.kellyklosure.com DOOR INSTALLATION INSTRUCTIONS 9F S S SHEET